

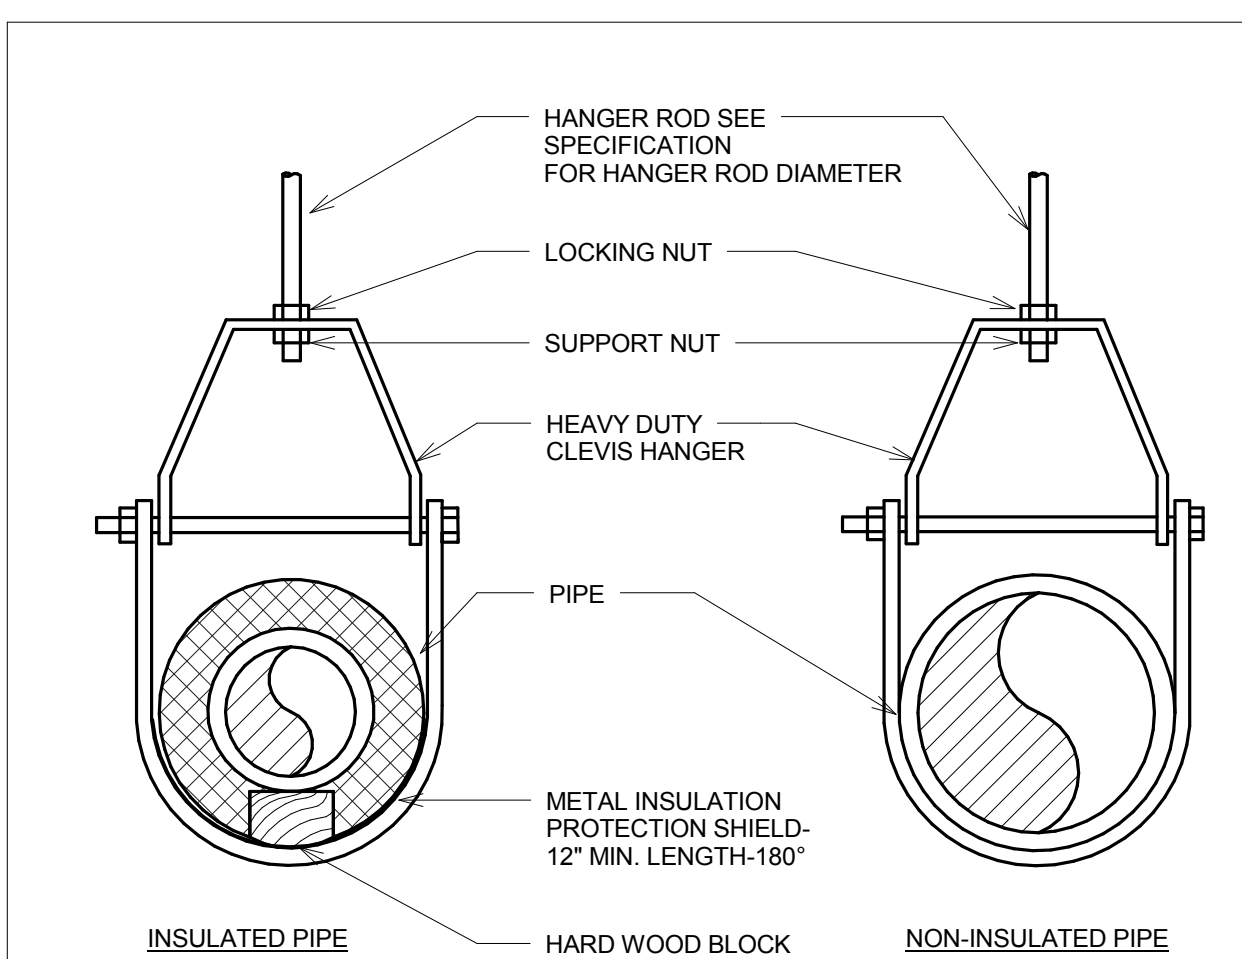
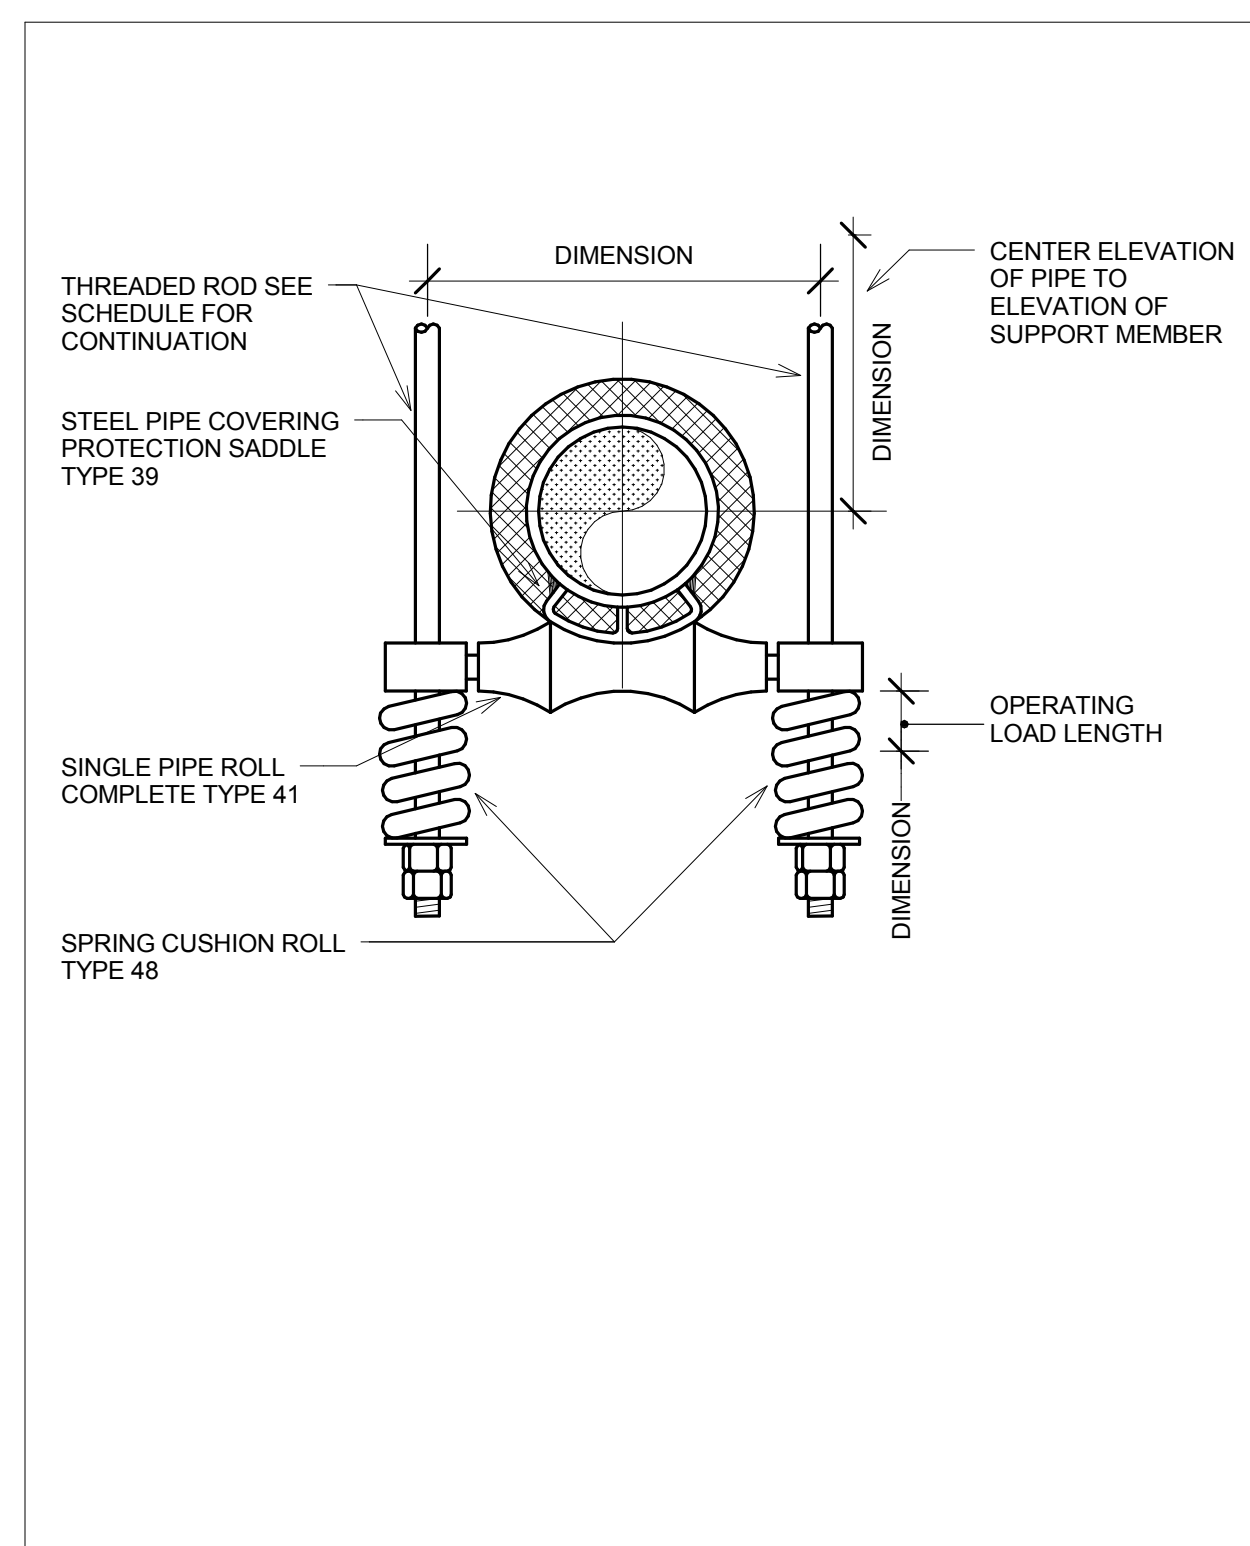
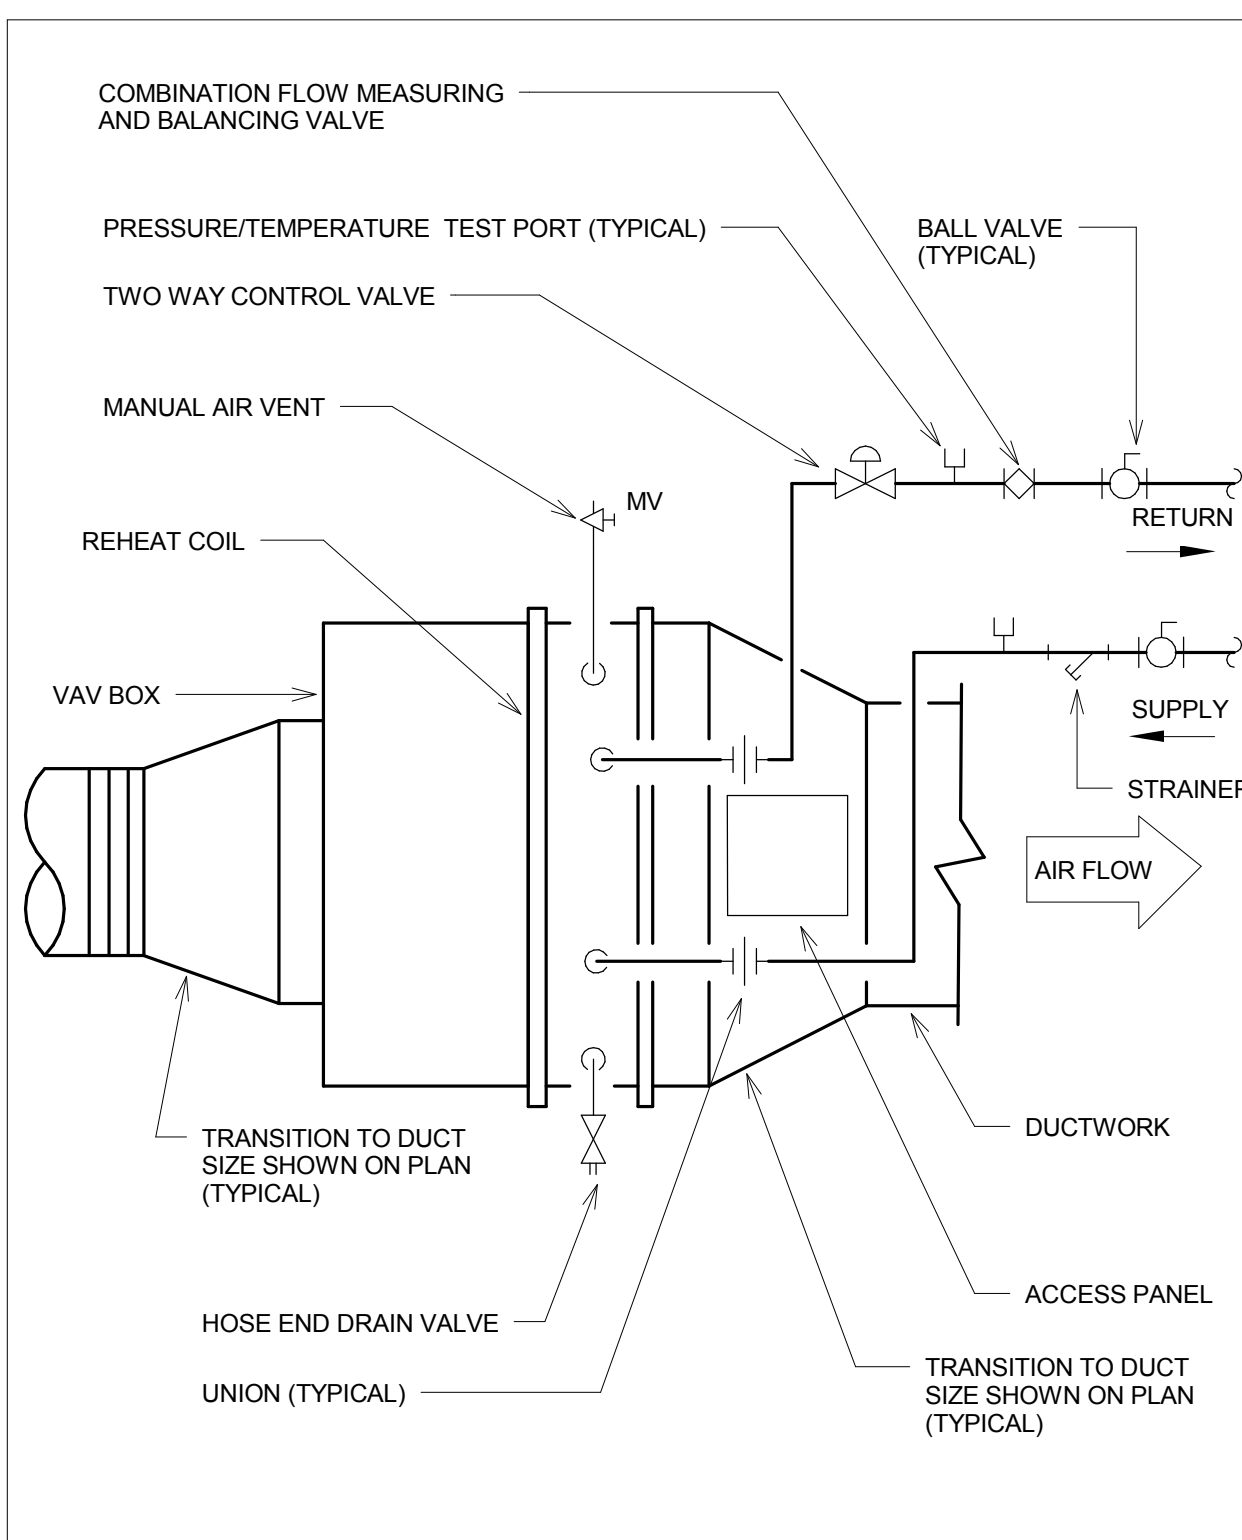
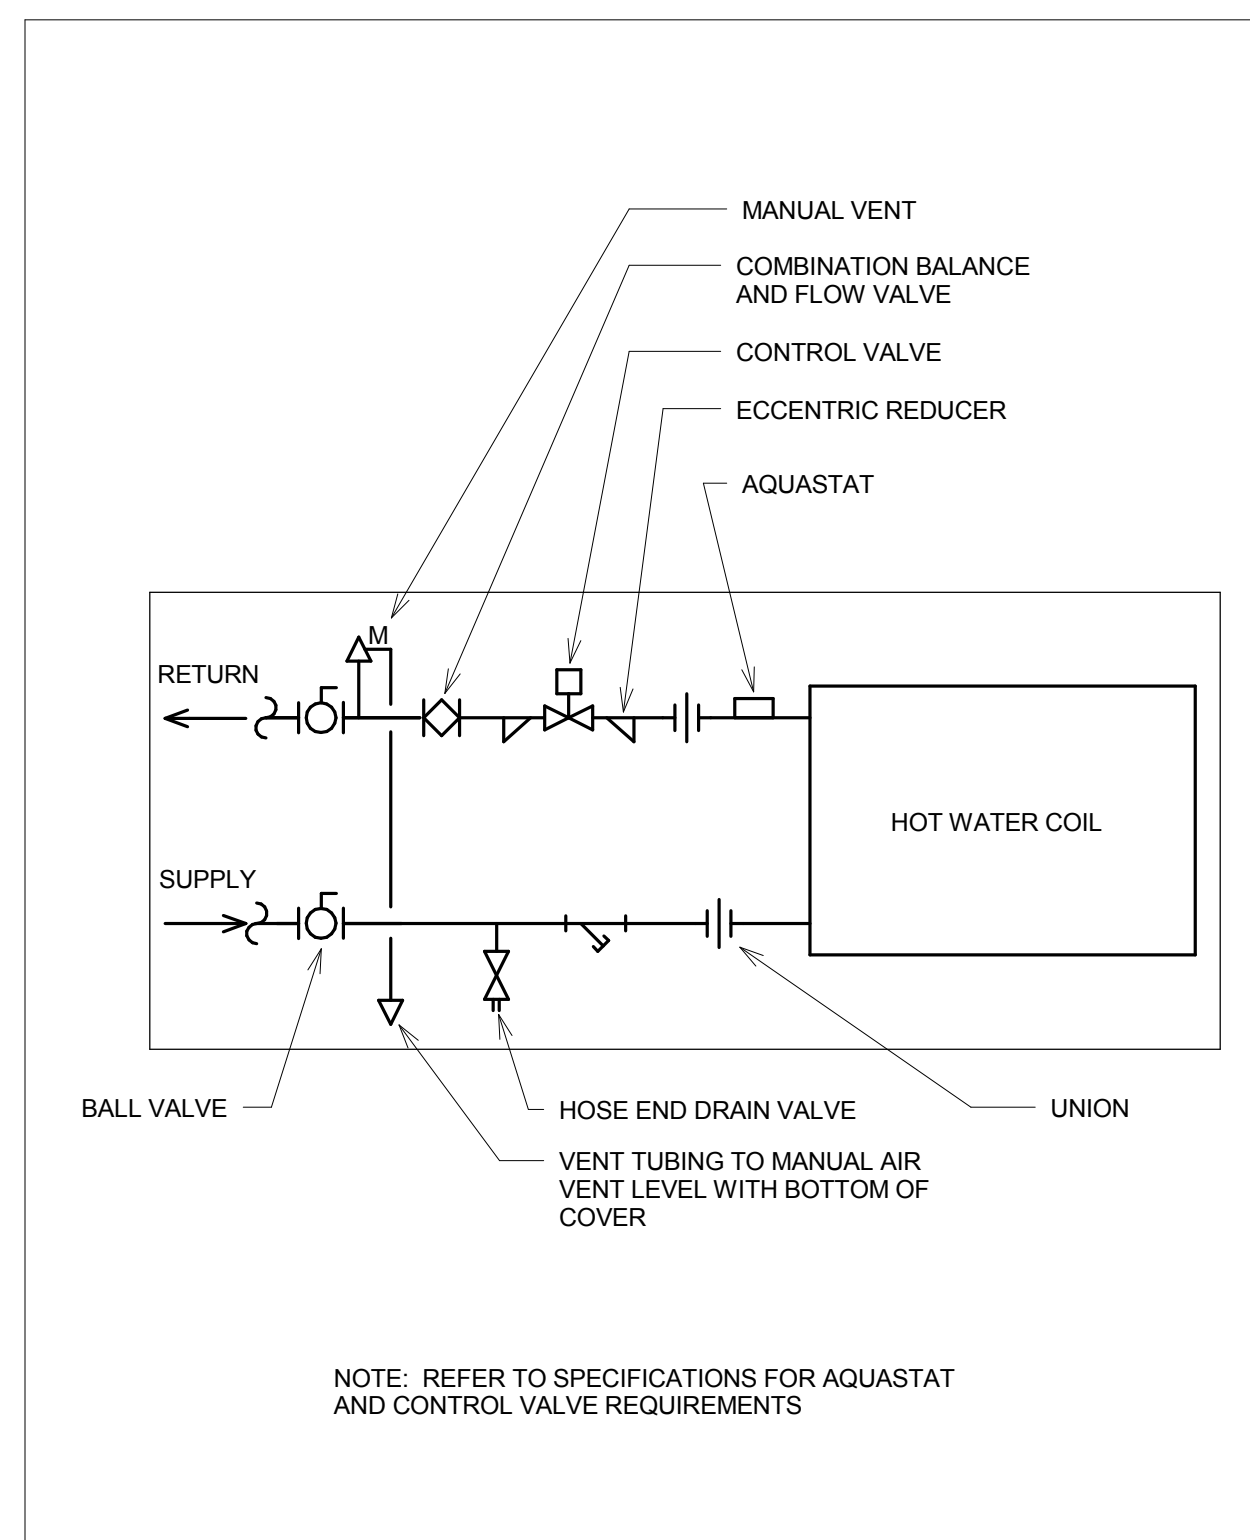
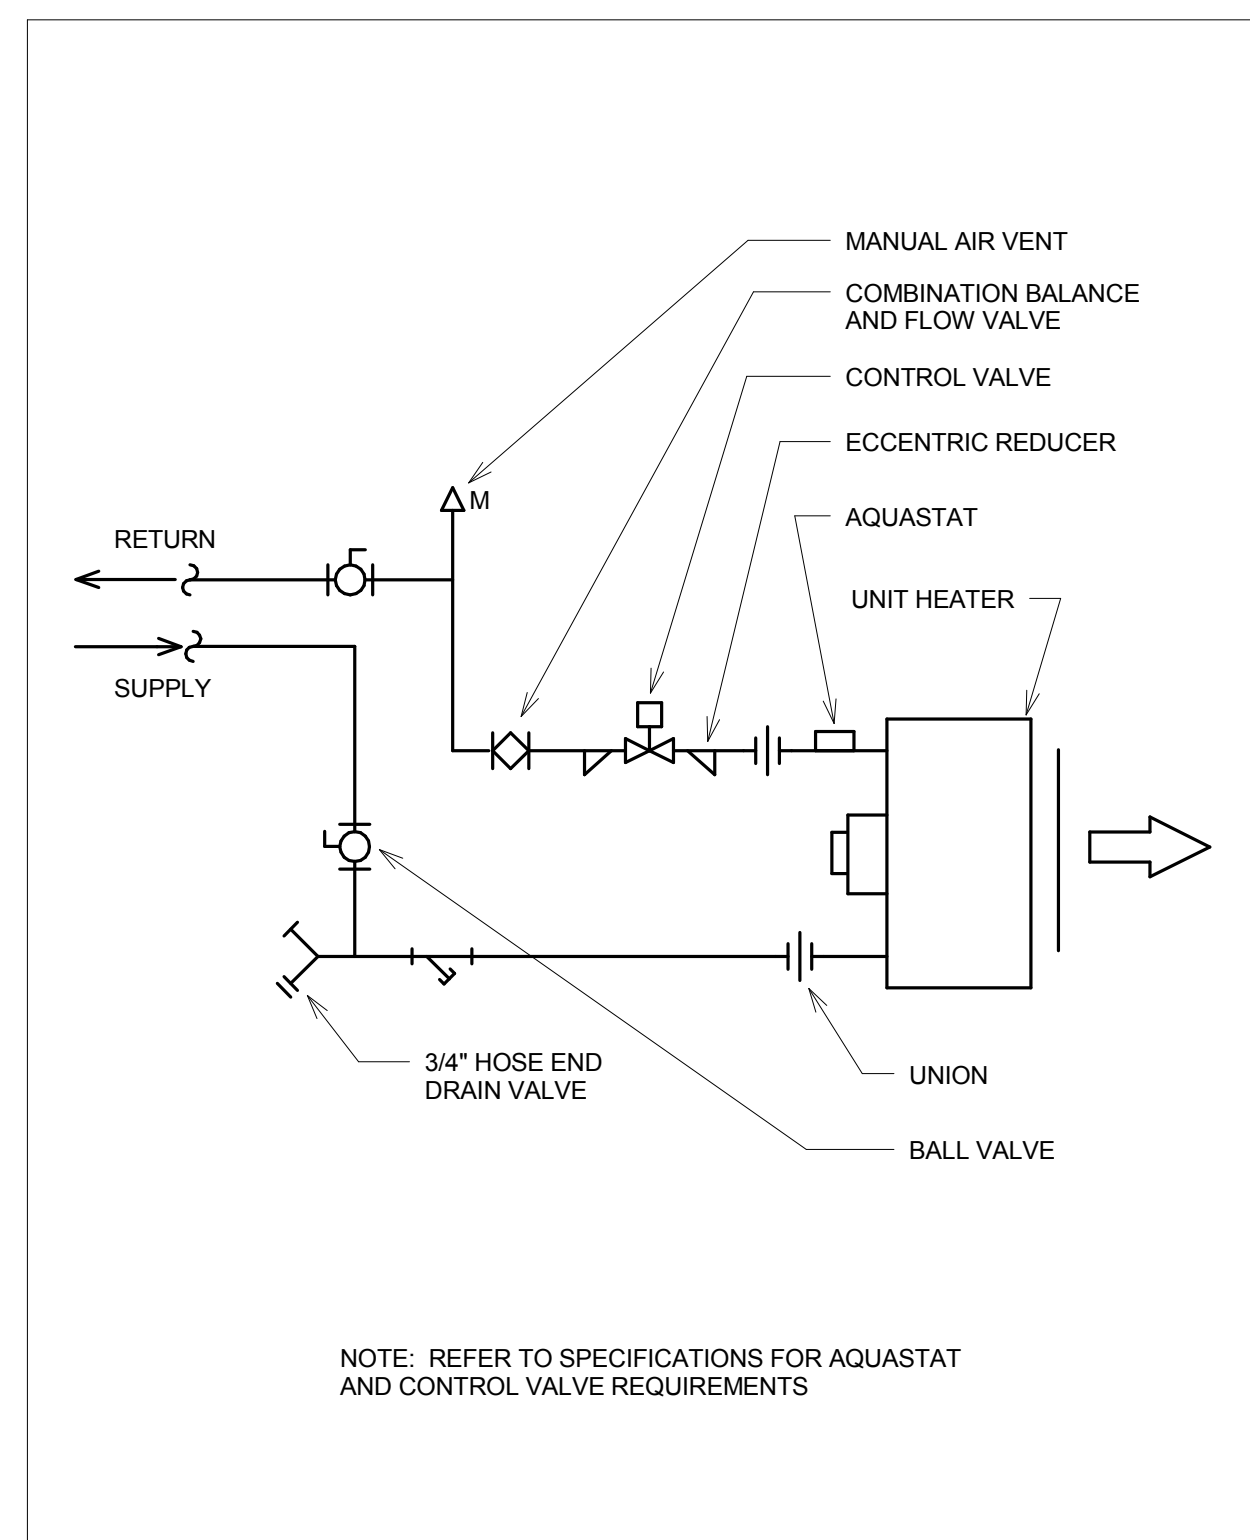


STEAM PRESSURE REDUCING STATION SCHEDULE																								
STATION	VALVE	SIZE	INLET PRESS (LBS)	OUTLET PRESS (LBS)	CAPACITY (LBS/HR)	MAX SOUND (DB)	% OF MAX VALVE CAP	A		B		C		D	E	F		G		H	I	J	K	
								SIZE (IN)	LENGTH (IN)	SIZE (IN)	LENGTH (IN)	SIZE (IN)	LENGTH (IN)			SIZE (IN)	LENGTH (IN)	SIZE (IN)	LENGTH (IN)					
PRV-01	#1	-	100	12	1700	-	90	2	2	20	3	30	3	---	---	---	---	---	---	---	---	---	---	
PRV-01	#2	-	100	12	1700	-	90	---	---	---	---	---	---	3	3	30	4	40	4	4	4	4	6	
PRV-01	#3	-	100	12	1700	-	90	---	---	---	---	---	---	3	3	30	4	40	4	4	4	4	4	

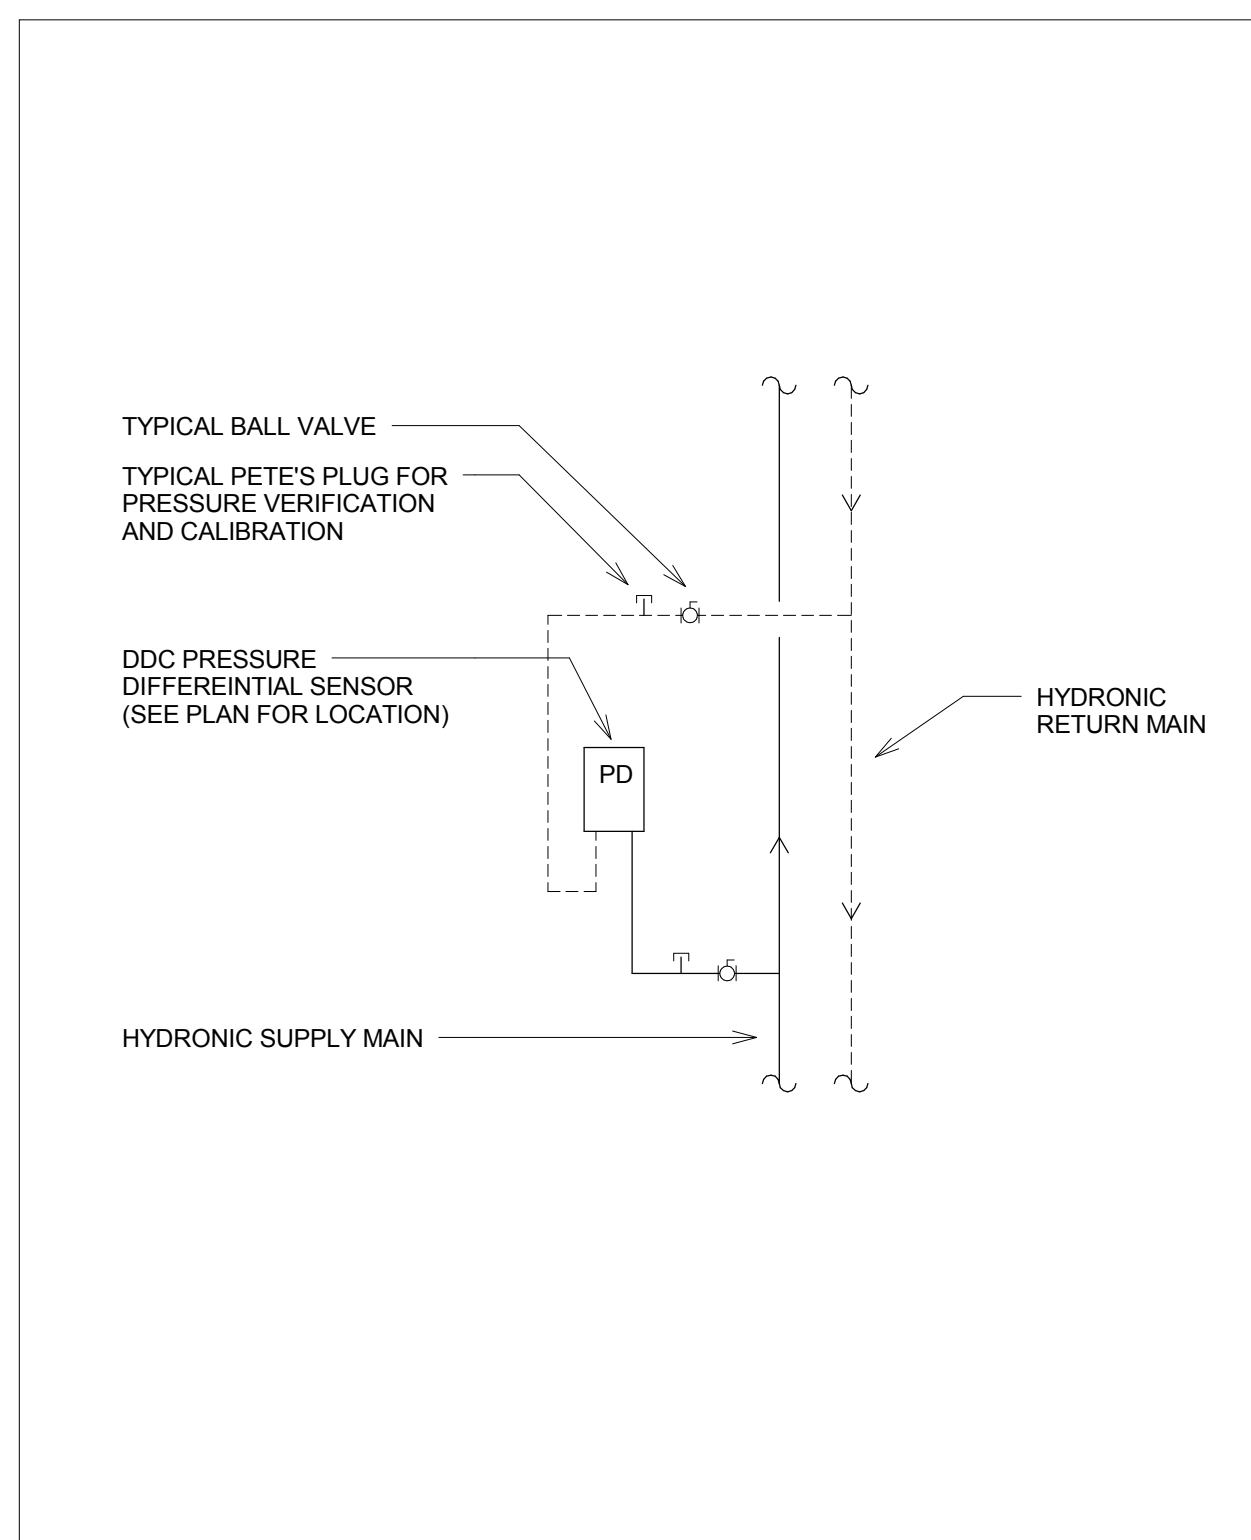

GENERAL NOTES:

1. SUSPEND MECHANICAL HANGER FROM UNISTRUT (OR EQUAL) SYSTEM WITH ADEQUATE CAPACITY TO SUPPORT APPLIED LOADS. INSTALL DIRECTLY AT JOIST TOP OR BOTTOM CHORD PANEL POINTS. IF LOAD MUST BE INSTALLED BETWEEN PANEL POINTS, SEE STRUCTURAL DETAIL.
2. THIS DETAIL APPLIES TO ALL PIPES & SIZES UNLESS SPECIFICALLY NOTED OTHERWISE.
3. FASTEN HANGER RODS TO TOP CHORDS OF BAR JOISTS OR OTHER STRUCTURAL MEMBERS. DO NOT FASTEN TO ROOF DECK OR JOIST BRIDGING. DO NOT USE FOR STEAM PIPING SYSTEM.

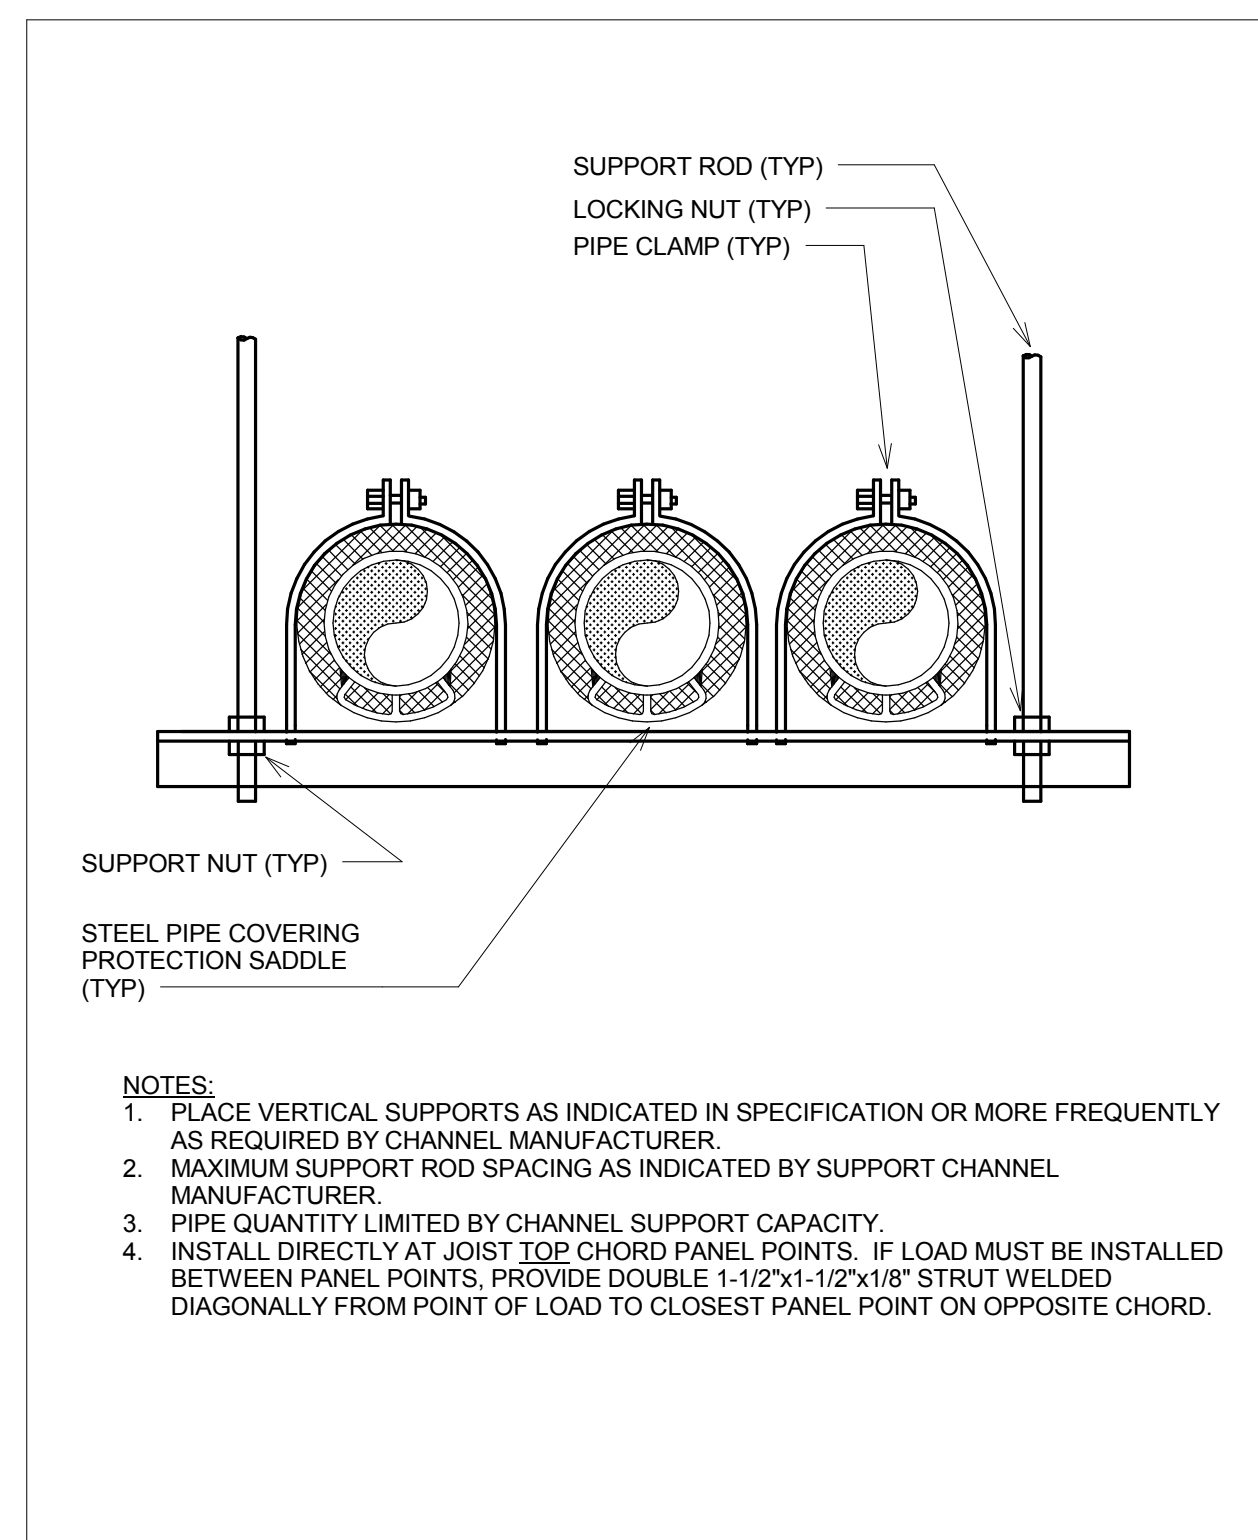

100% OWNER REVIEW
NOT FOR CONSTRUCTION
12/16/2011



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I hereby certify that this plan, specification or report was prepared by me or under my direct supervision and that I am a Professional Engineer under the laws of the State of Minnesota.

Signature _____

Registration No.

Date 11/17/2011

APPROVED: SERVICE LINE DIRECTOR	DATE:	APPROVED: INFECTION CONTROL NURSE	DATE:
APPROVED: GEMS COORDINATOR	DATE:	APPROVED: PATIENT SAFETY	DATE:
APPROVED: PROJECT SECTION MANAGER	DATE:	APPROVED: CHIEF OF POLICE	DATE:
APPROVED: DIRECTOR FMO	DATE:	APPROVED: SAFETY MANAGER	DATE:

DRAWING TITLE MECHANICAL DETAILS		PROJECT TITLE LONG TERM / INTERMEDIATE PSYCHIATRIC UNIT		DATE 12/16/2011	
				PLOT SCALE AS NOTED	
				PROJECT NO. 2032.001.00	
APPROVED: CHIEF OF STAFF		DATE	BUILDING NO	CHECKED BY	ISSUAN
				DM	BB
APPROVED: MEDICAL CENTER DIRECTOR		DATE	LOCATION		DRAWING NO.
		04/25	4801 VETERANS DR. SAINT CLOUD, MN		M400

